




PART SECTION D-D
SCALE - 1/100

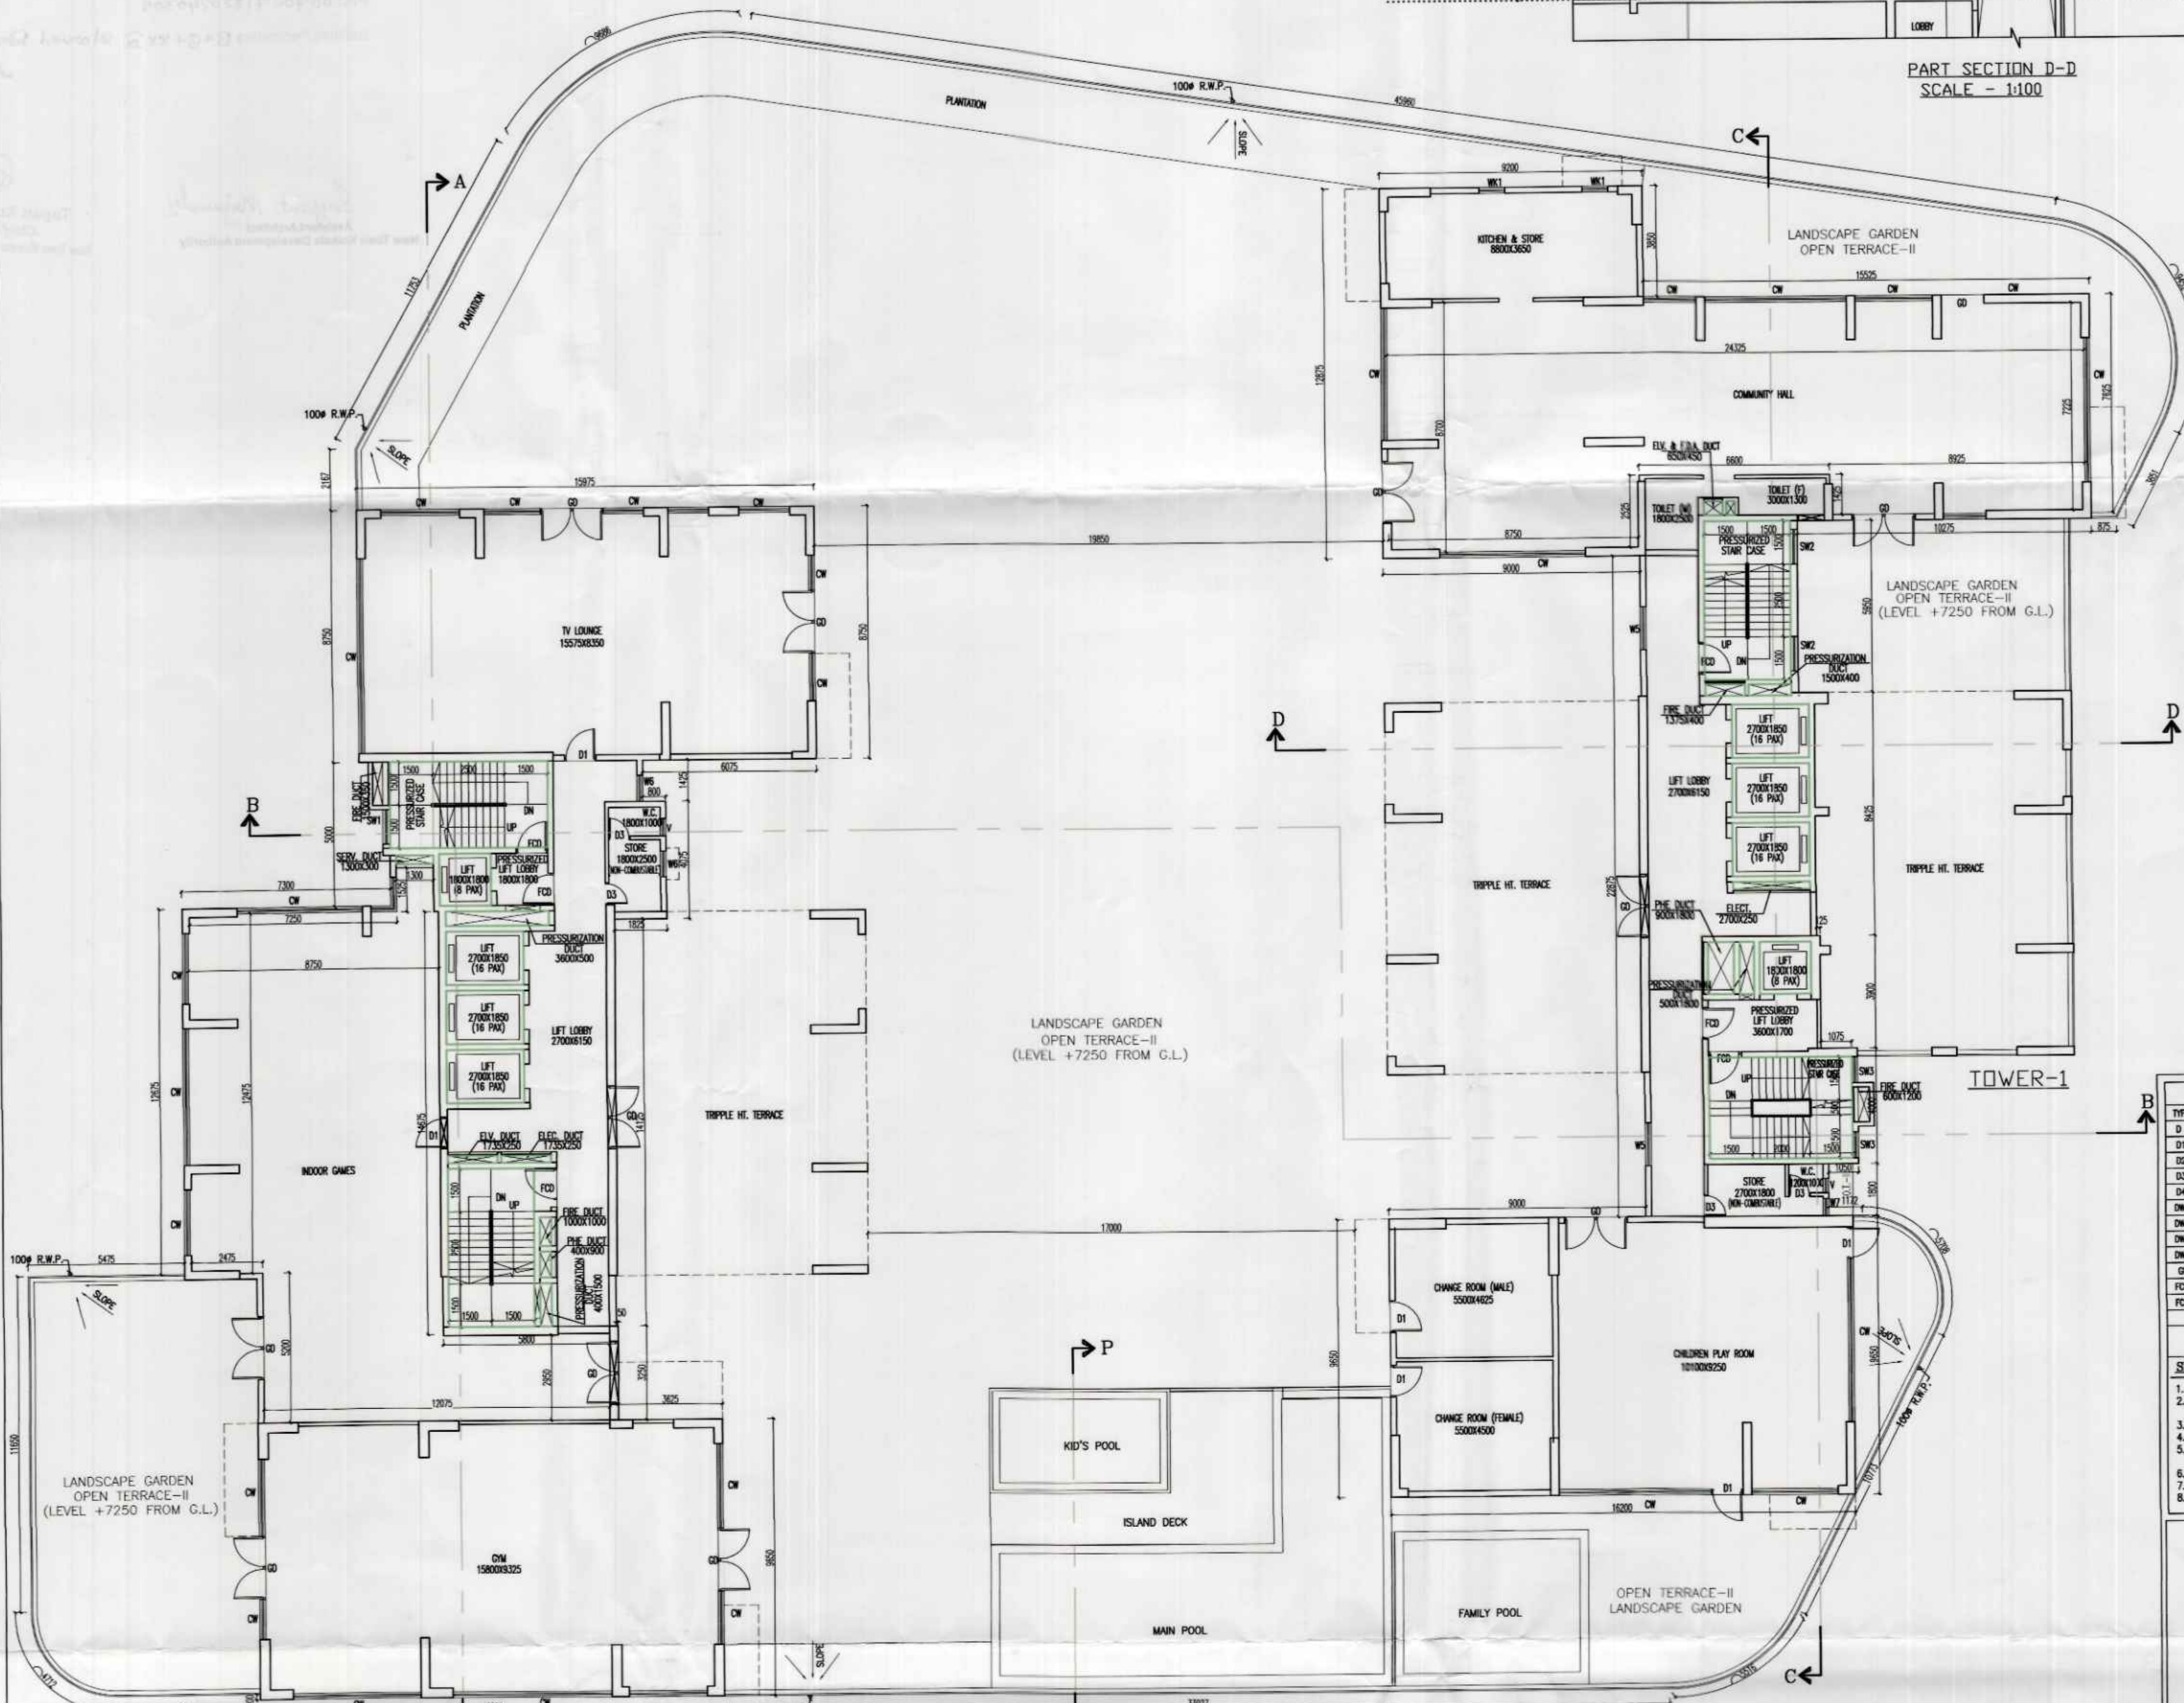


2ND FLOOR PLAN
SCALE - 1/100

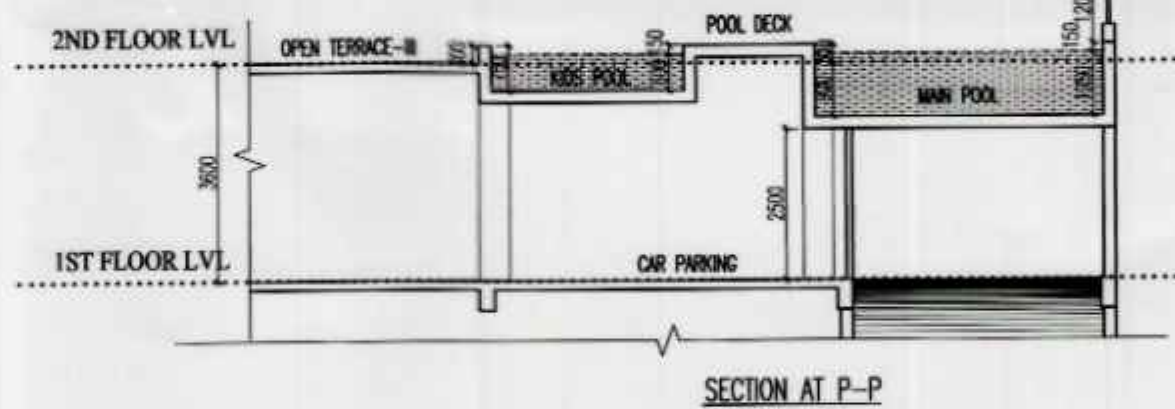

SECTION AT P-P
SCALE - 1/100

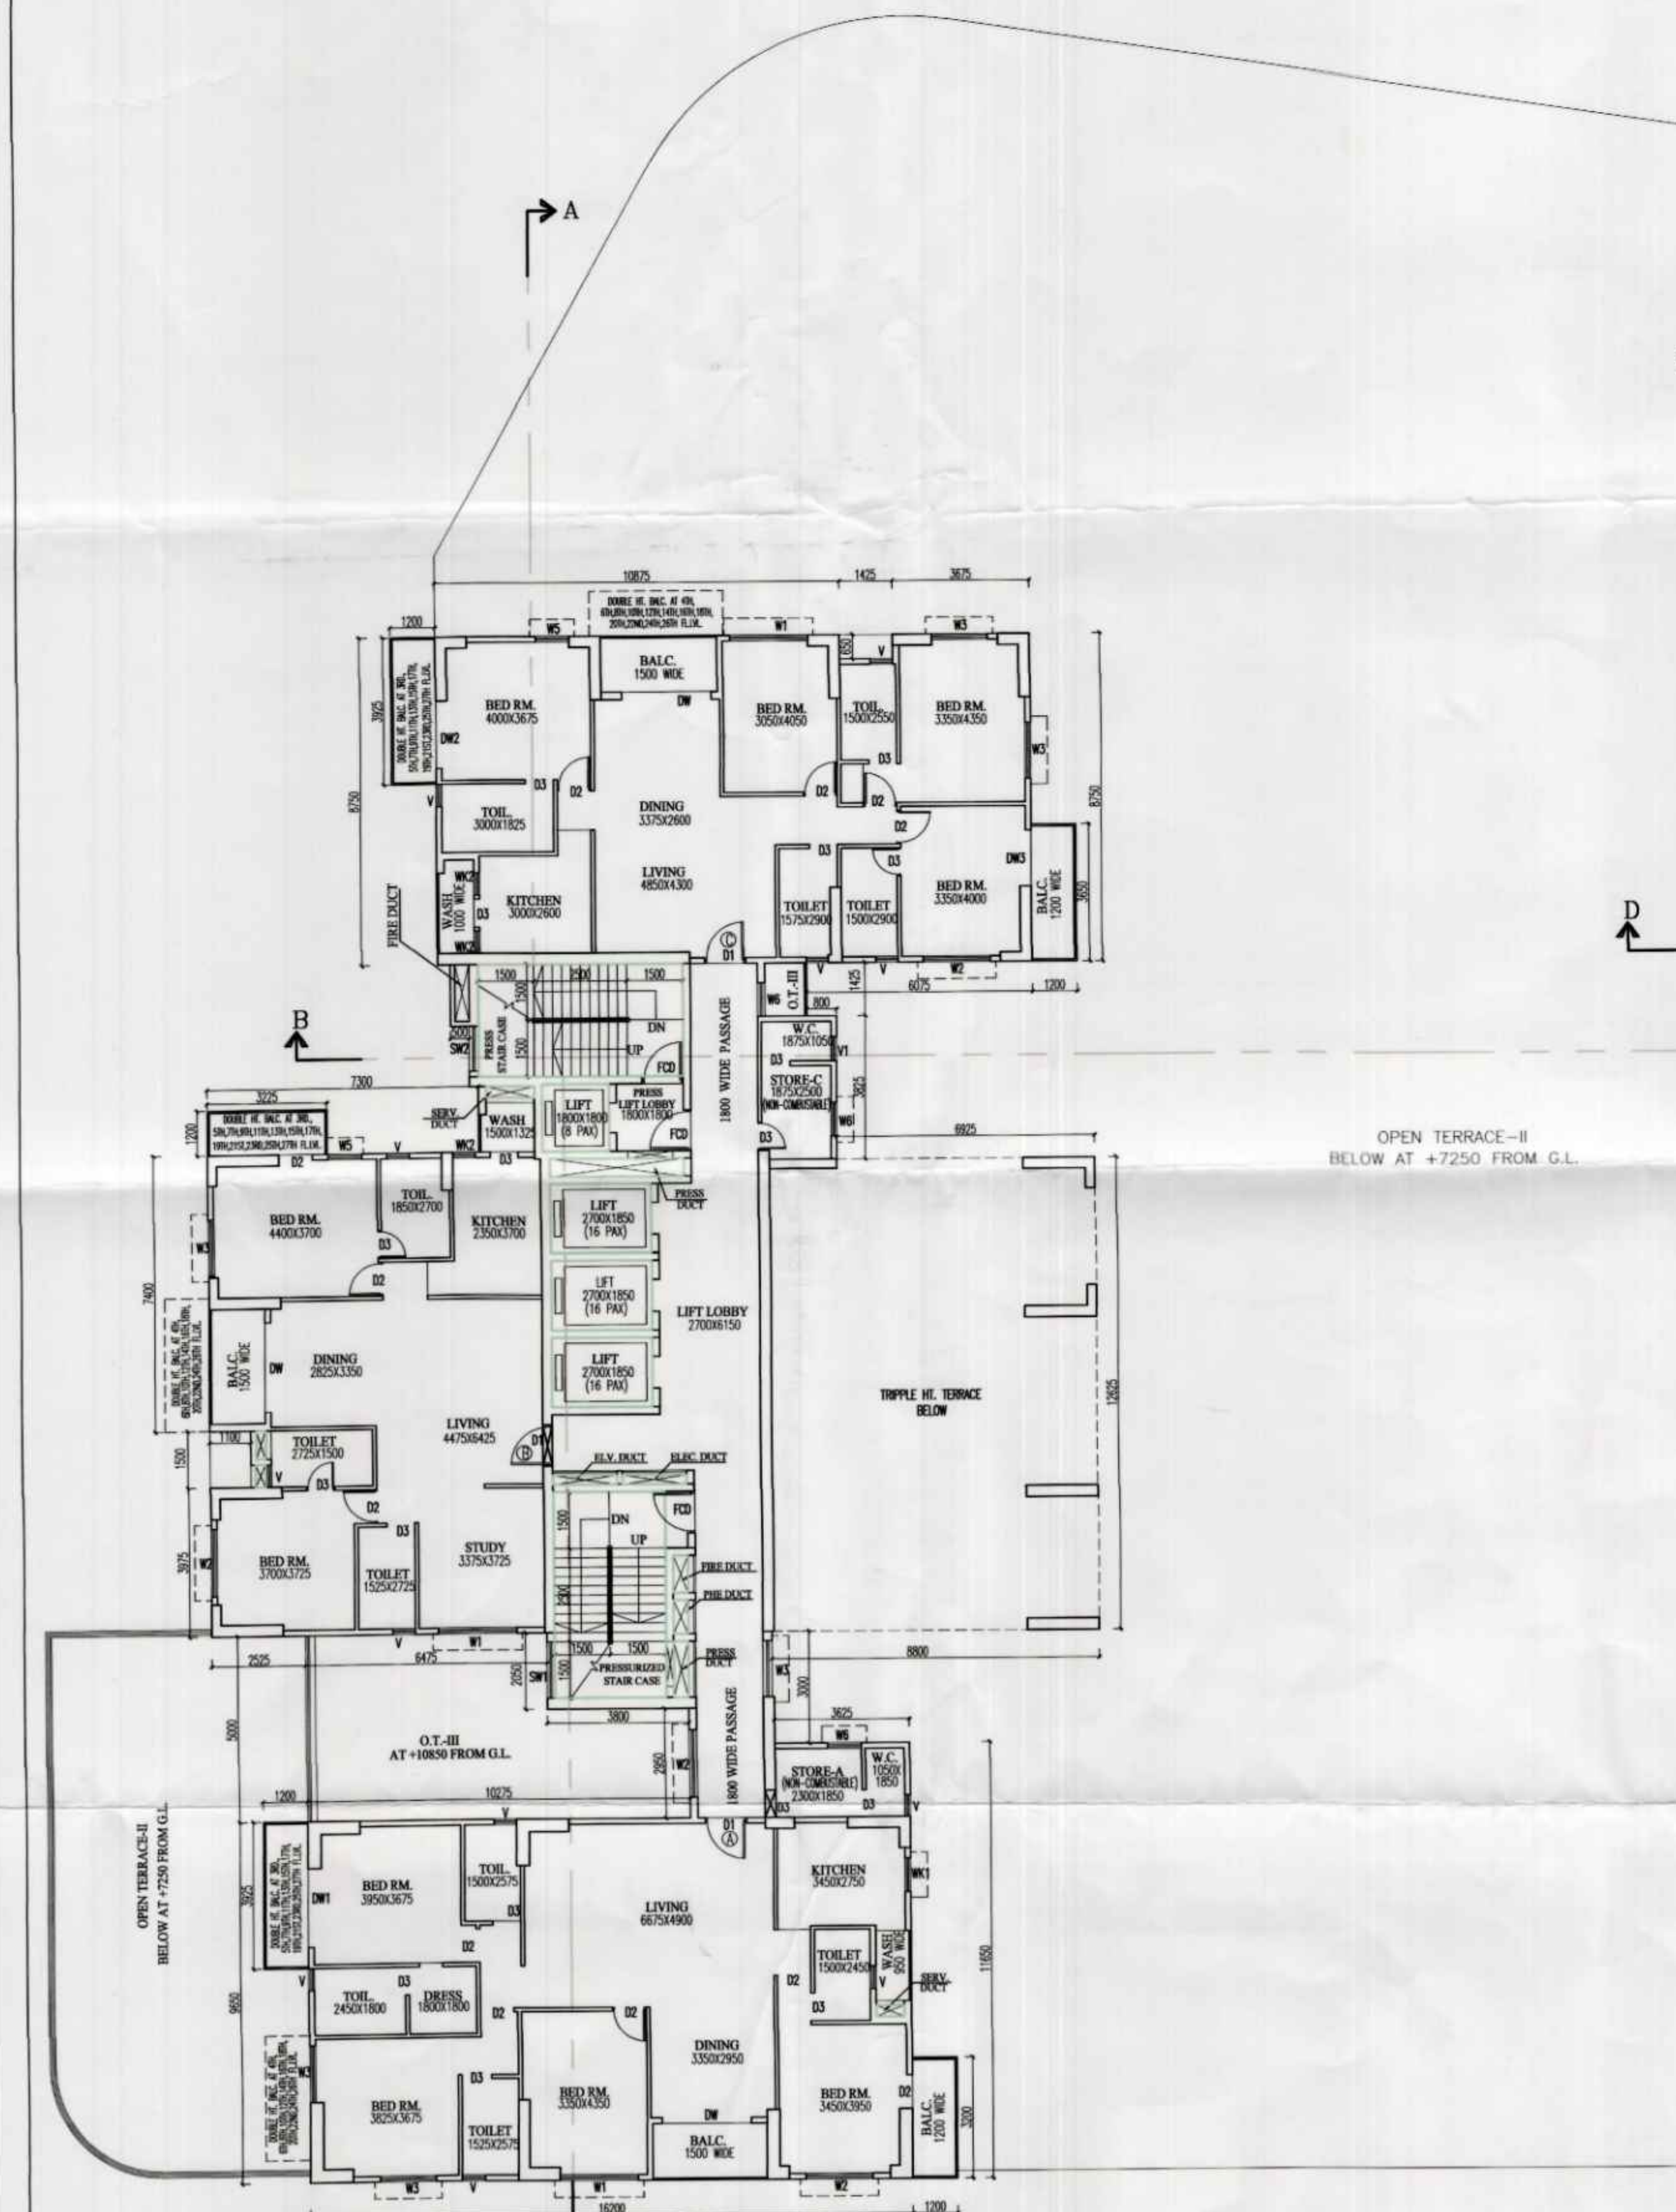

3RD FLOOR PLAN
TOWER-2

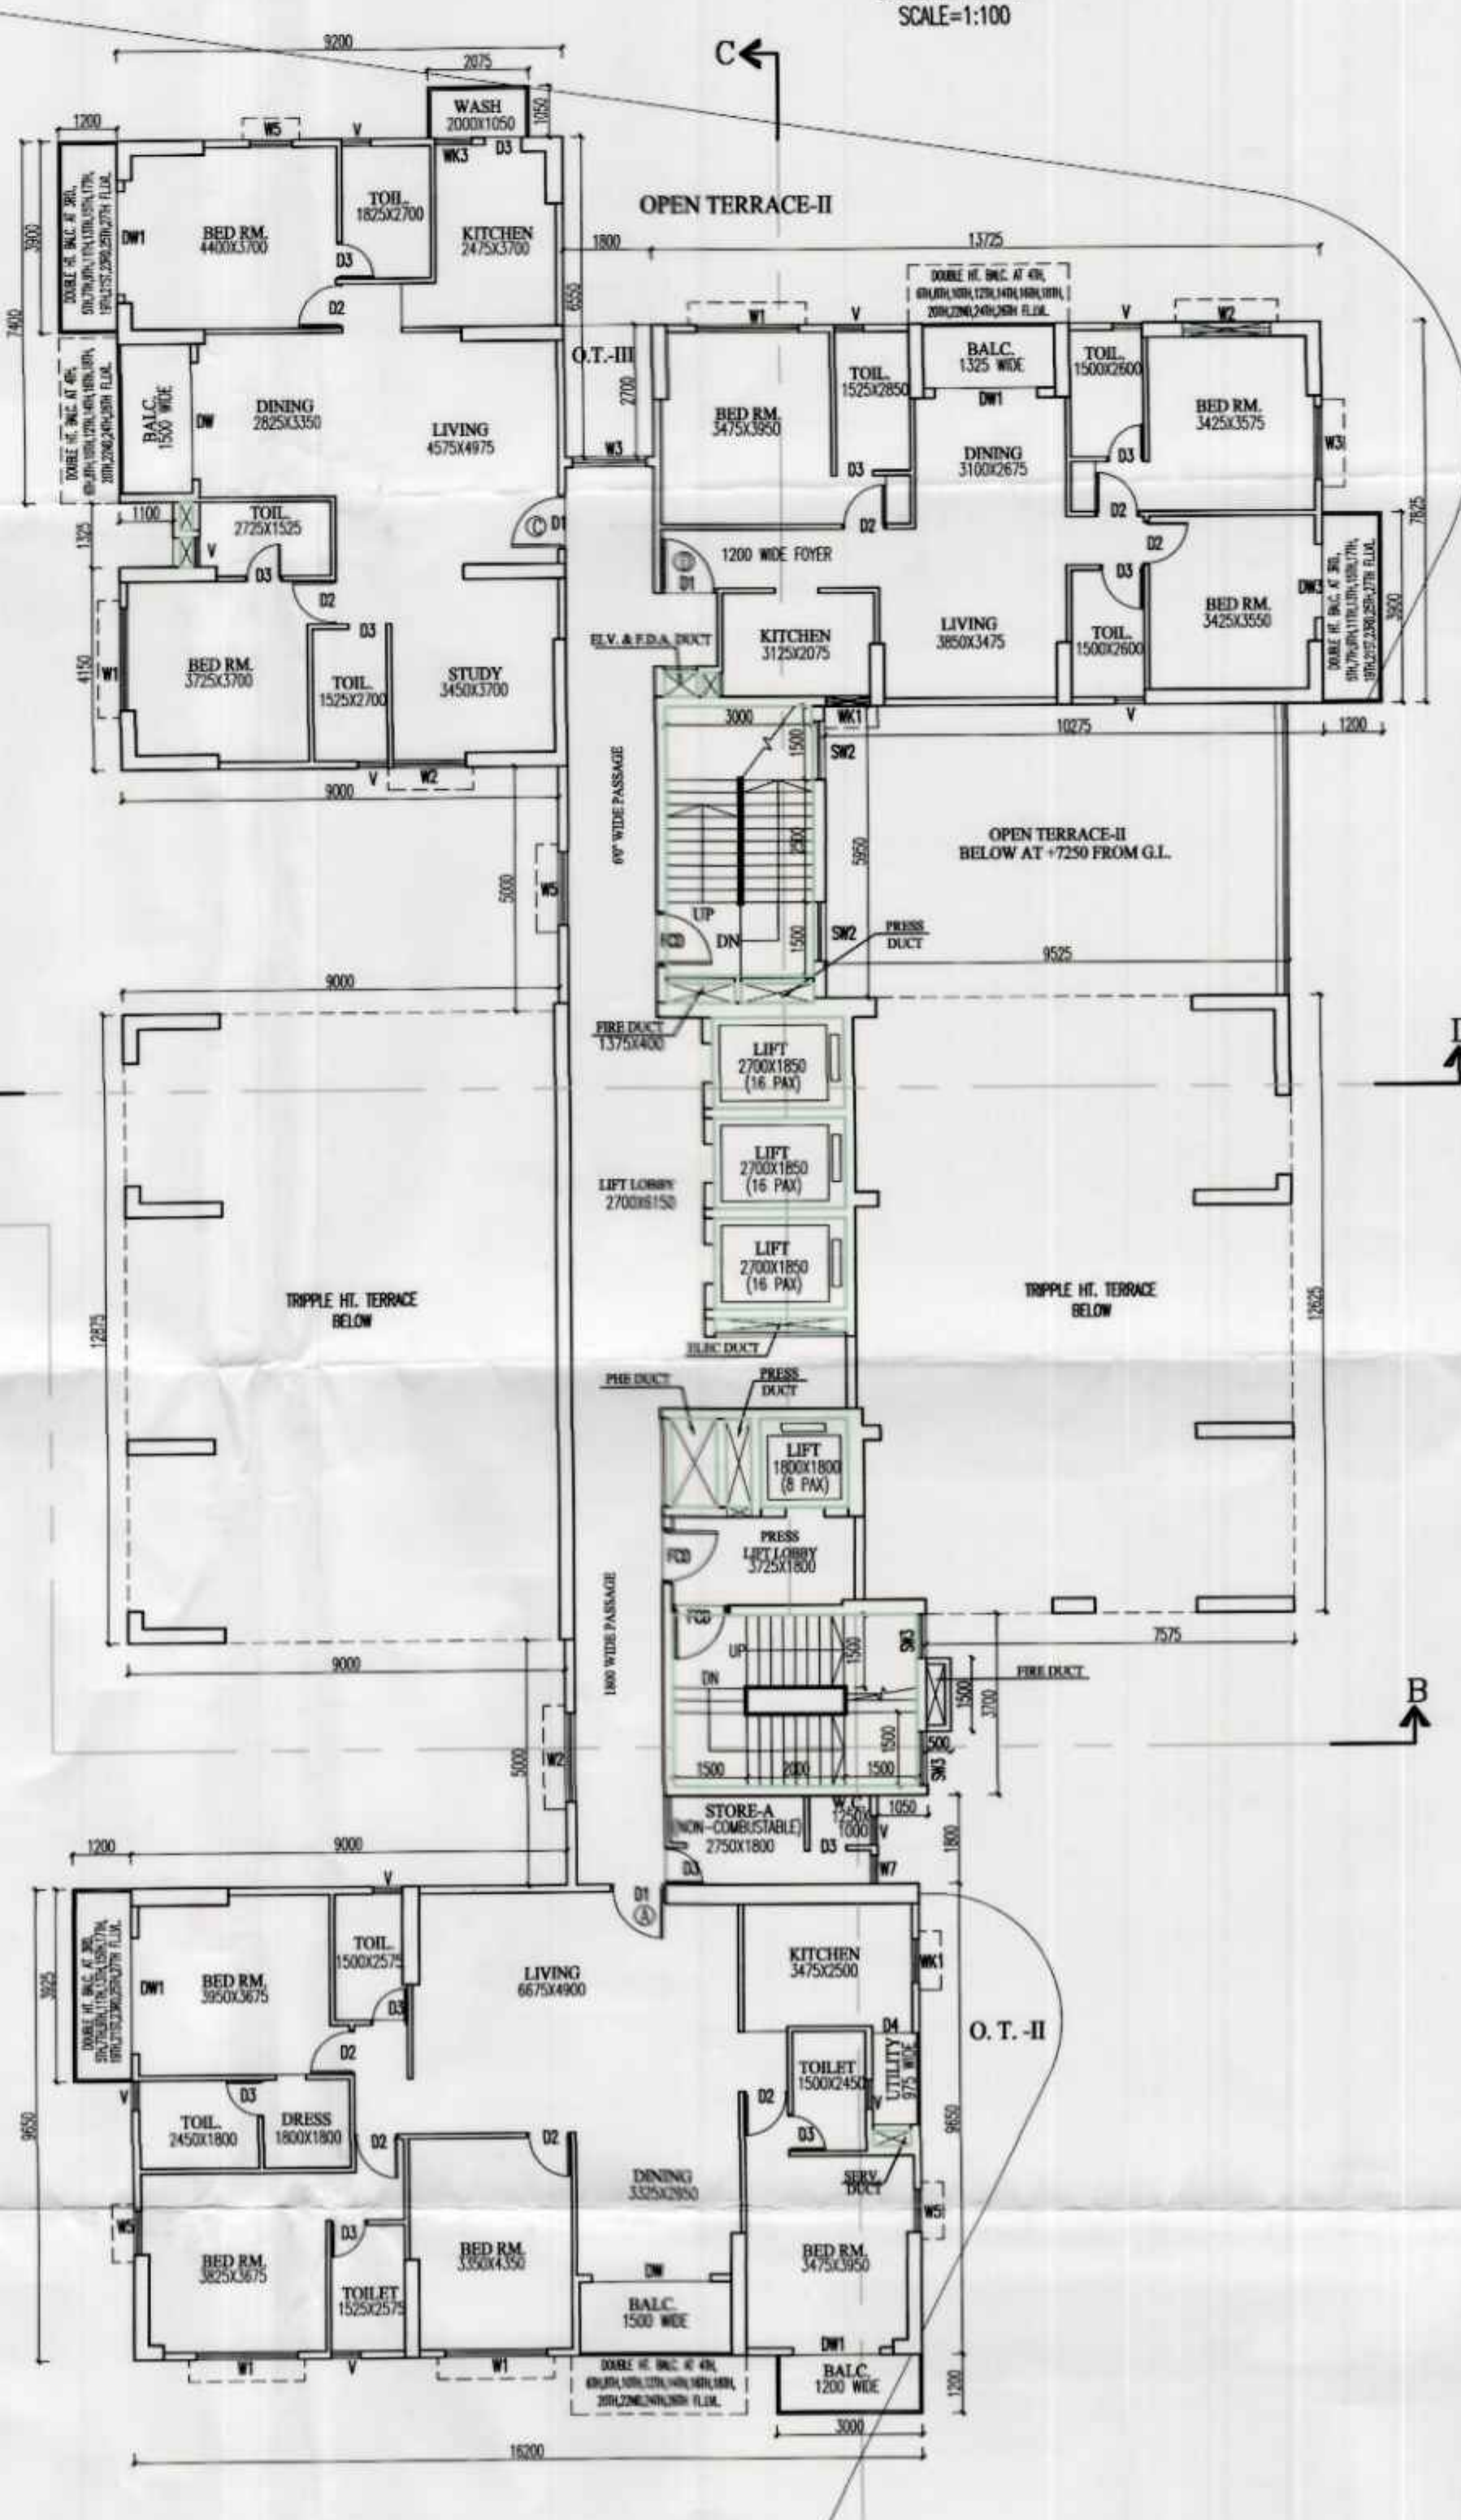

3RD FLOOR PLAN
TOWER-1

TYPE	NO.	SIZE	TYPE	NO.	SIZE
D	2300	2400X2000	W1	400	2300
D1	2300	1100X2000	W2	400	2300
D2	2300	800X2000	W3	400	2300
D3	2300	700X2000	W4	400	2300
D4	2300	700X2000	W5	400	2300
D5	2300	700X2000	W6	400	2300
D99	2300	700X2000	W100	400	2300

SCHEDULE OF DOORS & WINDOWS

SPECIFICATION OF BUILDING

- R.C.C. FRAME STRUCTURE WITH CONCRETE GRADE 1:1.5:2
- 200 M.M. THK. EXTERNAL 125 & 75 M.M. THK. INTERNAL WALLS WITH 14 COBALT MORTAR JOINTS.
- STEEL 2 - SECTION WINDOWS.
- 500 - 800 M.M. FLOORING.
- 1.5 & 1.4 COBALT PLASTER ON INTERNAL WALLS AND CEILING SYSTEMS.
- WATER PROOFING TREATMENT.
- 7.500 FINISH ON INTERNAL WALLS & CEILING.
- ALL CLIPBOARD NORTH IS 500.

FOR SHREE ISH PROJECTS PVT. LTD.
AS CONSULTING ARCHITECT OF
SHREE ISH PROJECTS PRIVATE LIMITED
AND 28 OTHERS.

SIGNATURE OF OWNER
HAR PRASAD SHARMA
DIRECTOR
SHREE ISH PROJECTS PVT. LTD.
ADDRESS: SA, MIDAH PARK, KOLKATA-700055
No. GTER-HDCO/19/00000
23A/34 AAC BOSE ROAD, KOLKATA-700020

IT IS CERTIFIED THAT THE COMPREHENSIVE GEO-TECHNICAL REPORT ON SOIL INVESTIGATION HAS BEEN PREPARED BY ME FOR DESIGN AND FOUNDATION OF THE FOUNDATION BY ANALYSING THE SOIL SAMPLE FOR ESTIMATING THE BEARING CAPACITY OF THE SOIL ON WHICH FOUNDATION OF THE STRUCTURE WILL BE CONSTRUCTED. I SHALL ALSO CHECK THE NATURE OF THE SOIL AFTER EXCAVATION AT SITE SO THAT FOUNDATION IS EXTENDED UP TO APPROPRIATE DEPTH THAT HAS BEEN PROPOSED IN THE GEO-TECHNICAL REPORT.

ALOK ROY
Empaneled Geotechnical Engineer
Kolkata Municipal Corporation (CIVIL, MCE, Soil & Foundation, Engg)
Class-I, No.- 6.7/1/11
SA, Midah Park, Kolkata-700055
No. GTER-HDCO/19/00000
Kolkata-700 024

SIGNATURE OF GEO-TECHNICAL ENGINEER
ALOK ROY
GTER-HDCO0900003

CERTIFICATE OF STRUCTURAL ENGINEER
CERTIFIED THAT THE STRUCTURAL DRAWING AND DESIGN OF BOTH THE FOUNDATION AND SUPERSTRUCTURE OF THE BUILDING/BUILDINGS HAS BEEN MADE CONSIDERING THE SOIL TEST REPORT, (AS PER THESE RULES AND REGULATIONS MADE UNDER THE ACT) AND ALSO CONSIDERING ALL POSSIBLE LOADS, SEISMIC LOAD AND THE MOMENTS GENERATED BY THE PROPOSED STRUCTURE AS PER THE BUREAU OF INDIAN STANDARDS AND NATIONAL BUILDING CODE OF INDIA AND CERTIFIED THAT IT IS SAFE AND STABLE IN ALL RESPECT AND THESE PROVISIONS SHALL BE ADHERED TO DURING THE CONSTRUCTION.

SIGNATURE OF STRUCTURAL ENGINEER
ANJIT AGARWALA
STERANKDA1000105

CERTIFICATE OF ARCHITECT
I CERTIFY THAT ALL THE ARCHITECTURAL DRAWINGS OF THE PROJECT AT PREMISES NO. - 07/018 WITHIN ACTION AREA II OF NEW TOWN KOLKATA IN MOUDA-PANWARHATA, ALL NO. 36, UNDER PLOT NOS. M- II OF 3650, 3651, 3652, 3653, 3654 & 3656, P.S. TECHNICAL, DIST. NORTH 24 PRAGHAK.

SIGNATURE OF ARCHITECT
RAJ KUMAR AGARWAL
AGRAKNDAA1000106

TITLE
2ND FLOOR PLAN, 3RD FLOOR PLAN & PART SECTION AT P-P.

PROJECT
PROPOSED PLAN OF B+G+XIV STORED RESIDENTIAL BUILDING AT PREMISES NO. 07-018 WITHIN ACTION AREA II OF NEW TOWN KOLKATA IN MOUDA-PANWARHATA, ALL NO. 36, UNDER PLOT NOS. M- II OF 3650, 3651, 3652, 3653, 3654 & 3656, P.S. TECHNICAL, DIST. NORTH 24 PRAGHAK.

DATE 06.08.2023 **JOB NO.** MCH/19/2023 **SCALE** WITHIN **CHECKED SHEET NO.** 3 OF 13
SCALE 1:100 **ARCHITECTURAL DRAWING - 3/13**
ARCHITECT
RAJ AGARWAL & ASSOCIATES
M. 9030 SURESHKUMAR - 18

PARTY'S COPY

APPROVED FOR CONSTRUCTION
Any unauthorised construction done in violation
from approved building plan, after issuance of
this permission, will warrant revocation of the
construction permission.

STRUCTURAL DRAWINGS, STRUCTURAL
DESIGN CALCULATIONS & SOIL TEST
REPORT ARE NOT CHECKED AND KEPT
FOR RECORDS ONLY.

LEVEL OF TOP OF THE BOXORAN
AND LEVEL OF EXISTY ENTRY
ALONG THE PROPERTY LINE OF
ANY PLOT SHOULD BE AT P.M., THE
SETTY & SETTY SHOULD BE MADE WITH
TEMPORARY TYPE OF CONSTRUCTION,
LIKE PLYWOOD BLOCK OR EQUIVALENT.

NEW TOWN KOLKATA DEVELOPMENT AUTHORITY
Sanction of Building Plan for Construction Purpose

VALID FOR 5 YEARS

No. and date: 11-03-2024

PIN: 0070071820240305

Building Particulars: B+G+XXI Stowed Residential Building
At P.No. 07-0718

Suyant's Memorials
Assistant Architect
New Town Kolkata Development Authority

Rudra
Tapan Kumar Dwari
Chief Architect
New Town Kolkata Development Authority

